

Y PWYLLGOR CYNLLUNIO PLANNING COMMITTEE


18 HYDREF 2018

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AREA SOUTH






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APPLICATIONS RECOMMENDED FOR APPROVAL

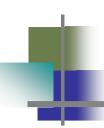




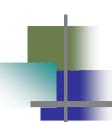





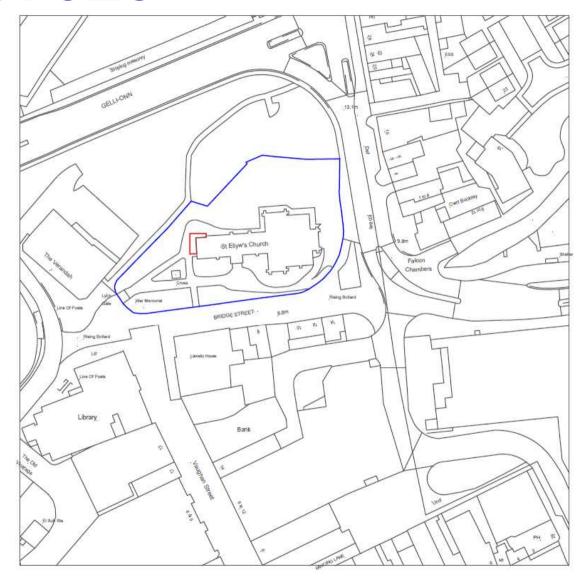










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Job: St Elli's Church, Llanell
Client: PCC

Drawing: Location Plan
Scale: 1:1250 @ A4
Date: May 2018



LOCATION PLAN ST ELLI'S CHURCH, LLANELLI, ST DAVID'S DIOCESE

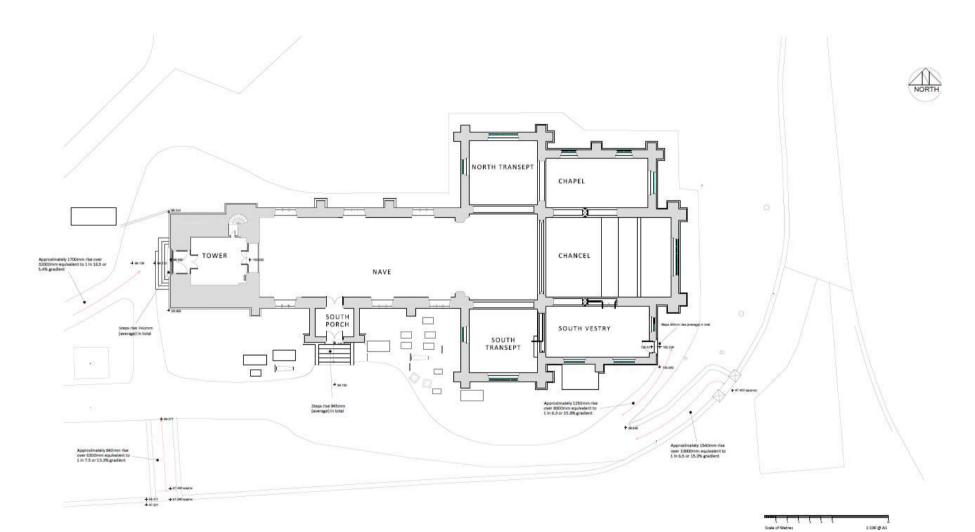

EXTERNAL ACCESS ARRANGEMENTS : AS EXISTING ST ELLI'S CHURCH, LLANELLI, ST DAVID'S DIOCESE

ARNOLD BARTOSCH L'



I Eath Mewn Bath Parade Chetenhan Gloscetarebby GL53 746

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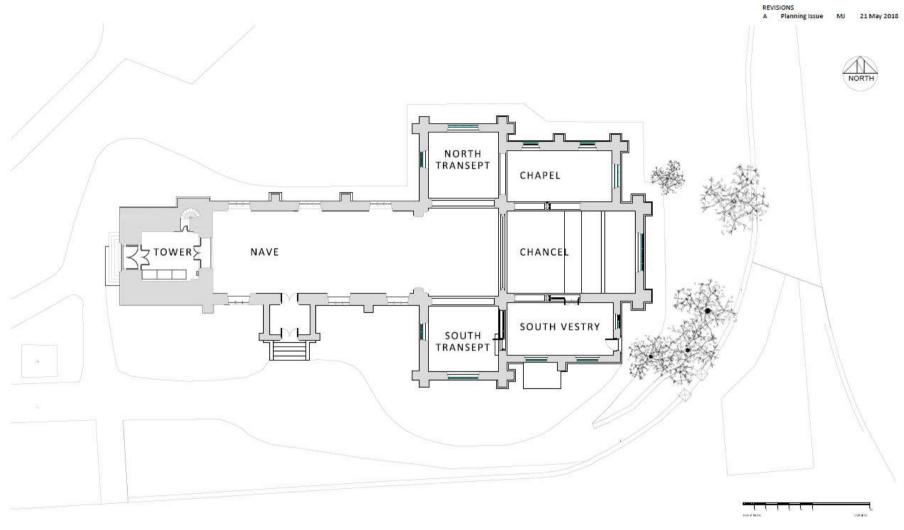
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Job: St Elli's Church, Llanelli
Client: Vicar and PCC

Drawing: External Access Arrangements : As Existing

Scale: 1:100 @ A1
Date: July 2018





GROUND FLOOR PLAN: AS EXISTING ST ELLI'S CHURCH, LLANELLI, ST DAVID'S DIOCESE









St Elli's Church, Llanelli, St David's Diocese

Ground Floor Plan- As Existing 1:100 @ A1



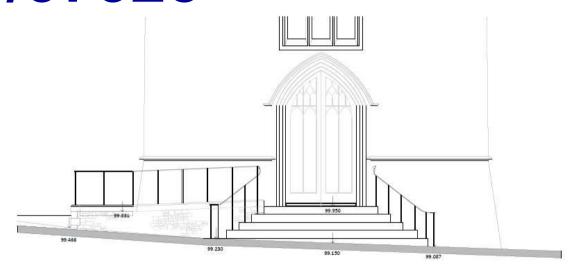

West Elevation

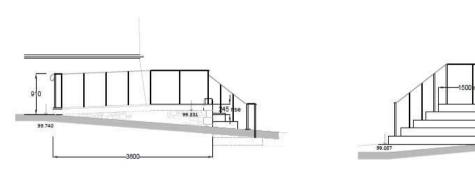

North Elevation

South Elevation

RAMPED & STEPPED ACCESS TO TOWER WEST DOOR: AS PROPOSED ST ELLI'S CHURCH, LLANELLI, ST DAVID'S DIOCESE

TOWER WEST ELEVATION STEP REMOVAL AND EXCAVATIONS

Locate and protect all services to proposed area of steps and ramp prior to works commencing. Protect existing structure to prevent damage.

Carefully remove existing wrought iron handrails to existing steps and set aside in secure location for possible reinstatement at completion of the proposed work.

Record position of all stonework forming west stepped access to assist in re-construction

Carefully lift and set aside all stonework associated with the steps and landing area; remove and dispose of off-site all core fill to existing step formation.

To proposed area of steps and ramp, carefully cut back existing tarmacadam surface; allow for protecting all exposed edges to prevent damage; dispose of excavated surface material off site. Average area 27.0m².

Carefully excavate to reduce level average 350mm below existing termacadam wearing surface for entire area of proposed steps and ramp. Average area 22.0m².

To proposed manhole position, carefully excavate to [750mm] below existing adjacent ground level; or required invert. Average size of excavation 900 x 1200.

Level and compact reduced level excavation in preparation for construction work.

STEPS AND RAMP CONSTRUCTION

Provide and lay 150mm thick clean hardcore sub-base; compact until no surface movement is evident when compacting.

Provide and install on minimum 33 mm high spacers type A242 reinforcement mesh to concrete slab; allow for stainless steel wiring between individual sections.

Carefully place everage 150 mm thick concrete sub-base to form level foundation for dressed stone kerb and relocated steps. Allow for thickening at edges to 250mm deep for 360 width.

Construct 150mm thick coursed and squared rubble randstone walling (to match existing stonework of church and to be approved by Contrust Alministrator) to external elevations of ramp as facing to 500mm biodivarions sub-waits build in wall list to biodivarior, sub-waits build in wall list to biodivarior, sub-waits 450mm centres vertically and 750mm horizontally in talgegered formation; install appearing memorane to all vertical surfuses and inflict over with 150mm layers of compacted hardcore upto 200mm bellow upper edge of kerb stones. Provide and lay dressed sandsdone kerb to exposed edge of ramp, swenge stones size 200 mm wide x 150mm days x 450mm long with chamfered extension arriage dressed to match proposed ramp profile; lay 50mm concrete blinding to hardcore surface finished to 112 gradient to match profile of tools exist. Allow for weep holes to per joint at 950mm centres.


Once concrete binding is cured and initial set achieved provide and lay 55mm thick Forest of Dean blue/grey Pernant sandstone sized in varing length and equal widther with both hammered wearing surface. Sample of buth hammered fribit to be approved by Contract Administrator prior to ordering. Allow for bedding on cementstand. Maintain separating membranes or all vertical surface.

Allow for drilling 27 no. hole positions in ctone kerb and steps to accept 30 x 20 square solid wrought iron handrall supports. Provide and securely fix in kerb 20 no. 20 x 20 wrought iron unights (everage length 900mm) complete with 50 x 20 wrought iron "unight in "b" and state in acting on the A. Allow for 4 coup paint finish to all metalwork; prime prior to fixing (colour to be agreed). Ramp, steps and handraits to fully comply (as far as i practicable) with Approved Document K of the current Building Requisitions.

To relocated steps, provide and install on minimum 33 mm high spacers type A242 reinforcement mesh to concrete slab; allow for stainlies steel wifing between individuals sections; carefully place average 150 mm thick concrete sub sector form level formation for stone ribers and treats. Allow for thickneing at edges to 250mm deep for 350 width. Install separating memorane to all vertical surfaces and as step construction progresses infill core with 150mm layers of compacted hardone upto 150mm between foreignesses above 178M, Lay 33mm thick concrete binding and lay 65 thick existing retained slabs as wearing surface. Carefully cut slabs to fit in and around manifole cover and frame (as it ferm 3.08.12).

To manhole located within steps ensure no debris enters the drainage as work progresses; protect brickwork from damage from hardcore compaction.

Reinstate tarmacadam wearing surfaces where cut back

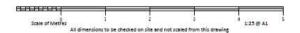

ARNOLD BARTOSCH LTD
Chartered Surveyors
Historic Building Consultants

RICS

1 Bath Mews Bath Parade Cheltenham Gloucestershire GCS3 7HL

T: 01242 522061 F: office@arnoldbartrach.co.uk

Job: St Elli's Church, Llanelli, St David's Diocese

Client: PC


Drawing: Ramped and Stepped Access to


Tower West Door : As Propoesed

Scale: 1:25 @ A1

Date: May 2018

2722 43

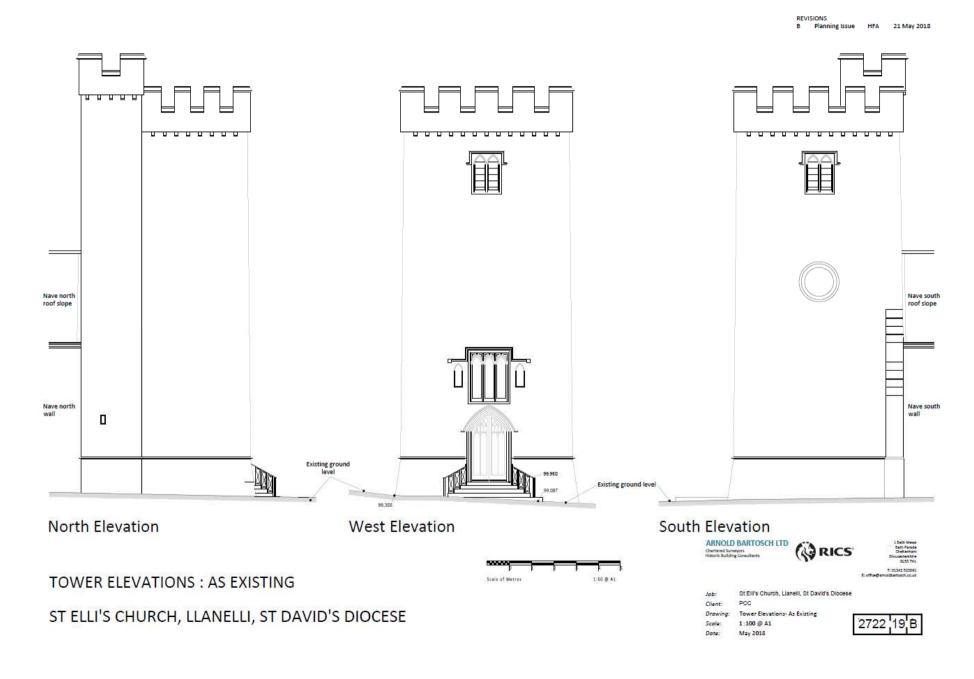

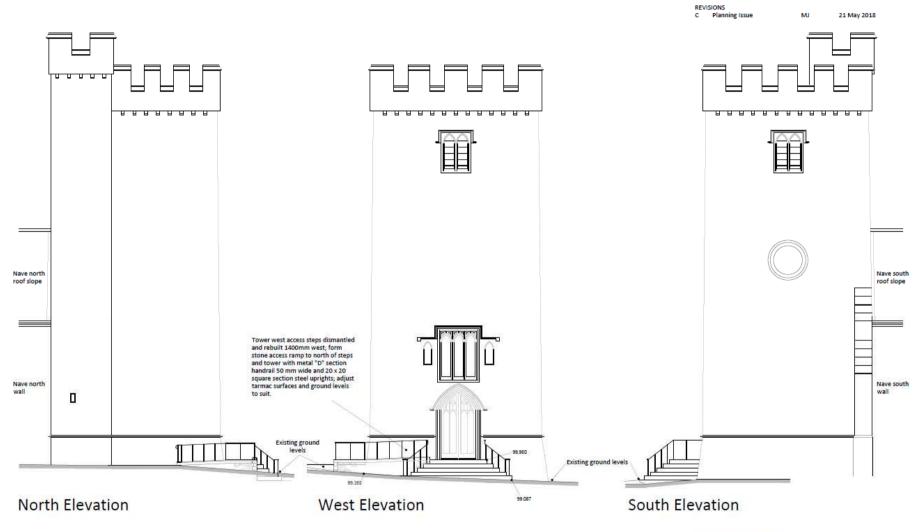

ELEVATIONS: AS PROPOSED

ST ELLI'S CHURCH, LLANELLI, ST DAVID'S DIOCESE








St Ell's Church, Lianelli, St David's Diocese

Client:

Elevations- As Proposed 1:100 @ A1 May 2018



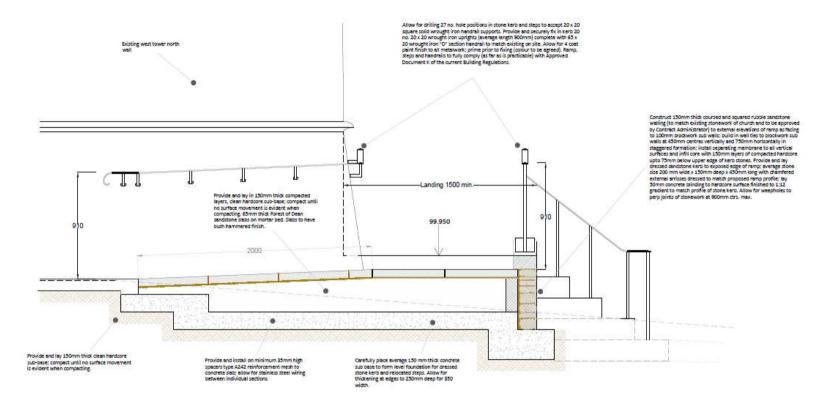

RAMPED AND STEPPED ACCESS TO TOWER WEST DOOR: PROPOSED DETAILS ST ELLI'S CHURCH, LLANELLI, ST DAVID'S DIOCESE



All dimensions are to be checked on site and not scaled from this drawing

ARNOLD BARTOSCH LTD

Chartered Surveyors
Historic Building Consultants



1 Bath Mews Sath Parade Chelterham Gloucestershire GL53 7HL

T: 01242 522061 Mos@emoisbertosch.co.uk

Job: At Elli's Church, llanelli

Client: F

Drawing: Ramped and Stepped Access:

Proposed Details

Scale: 1:10@ A1

Date: July 2018


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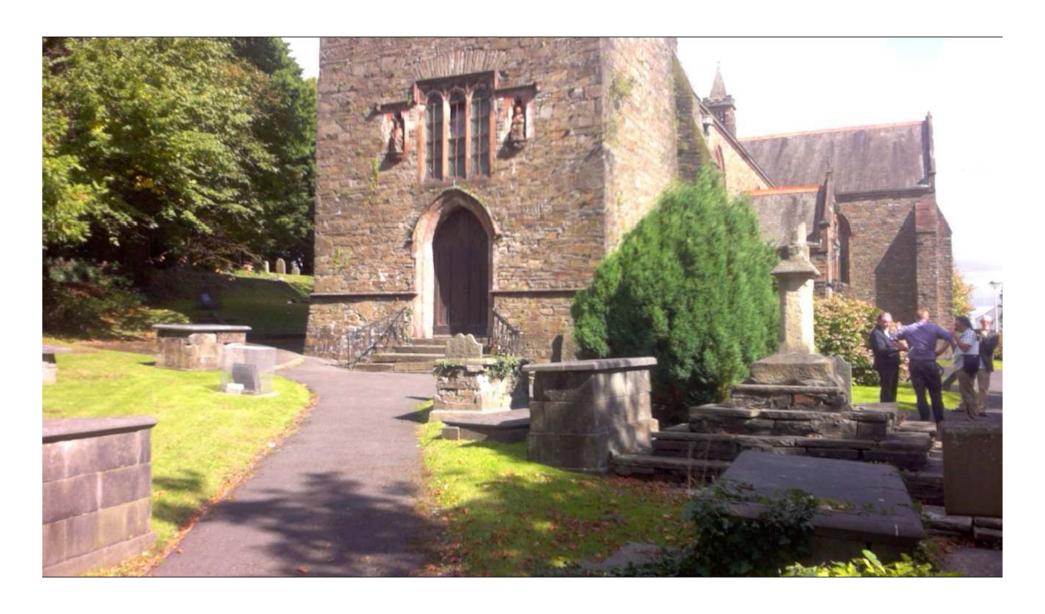
ST ELLI'S CHURCH, LLANELLI, ST DAVID'S DIOCESE (formerly drawing no. 2722/ 38 dated May 2018)

1:25 @ A1 May 2018








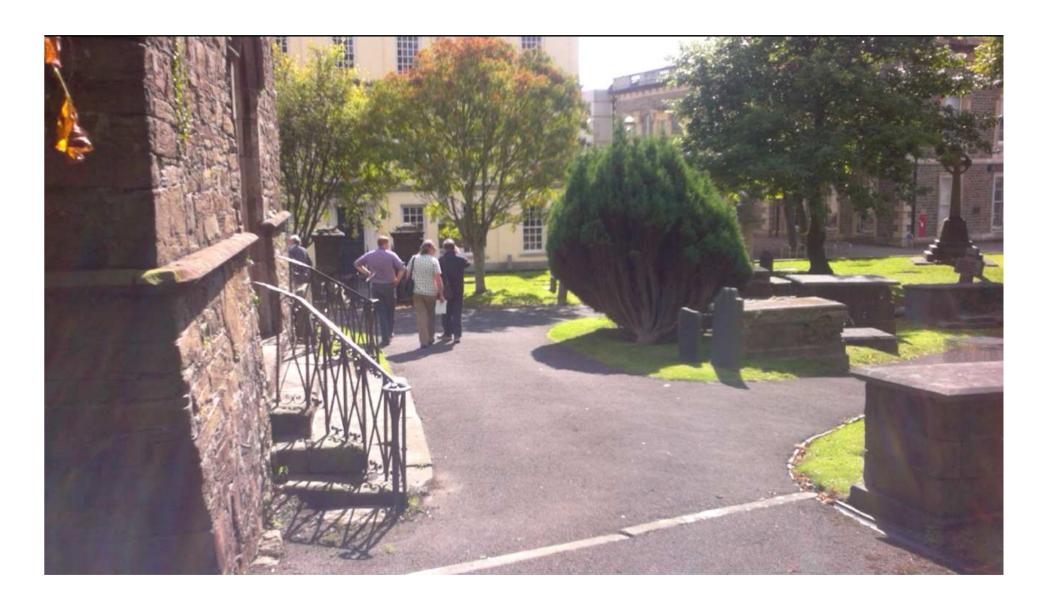




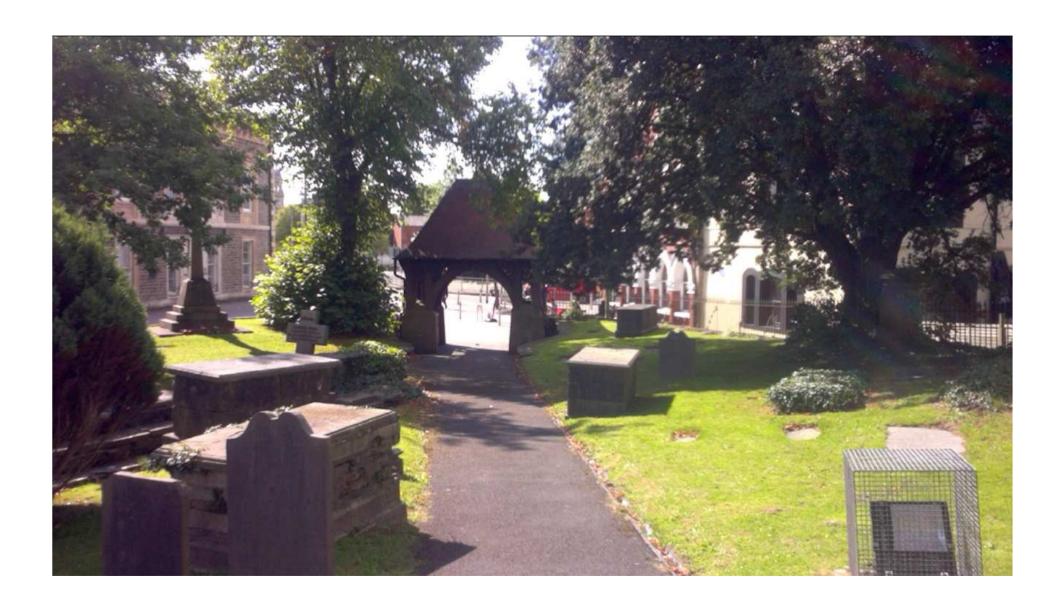






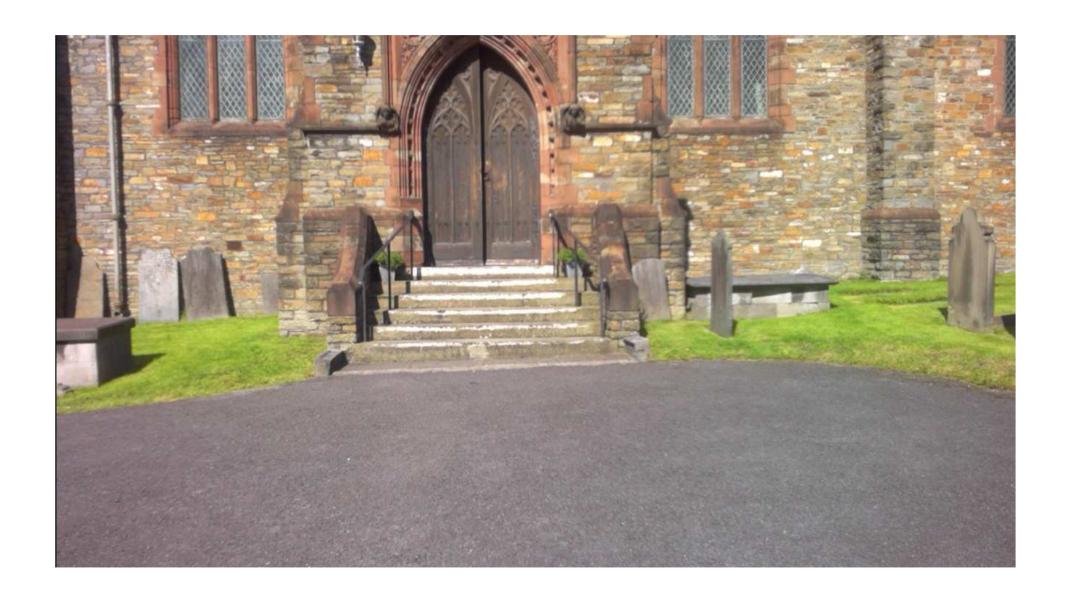





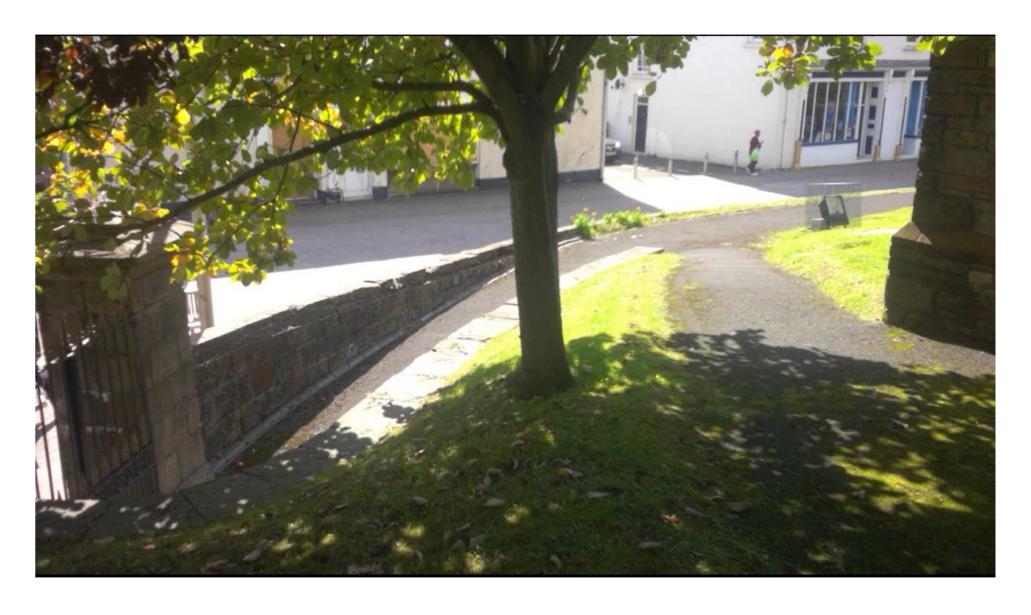













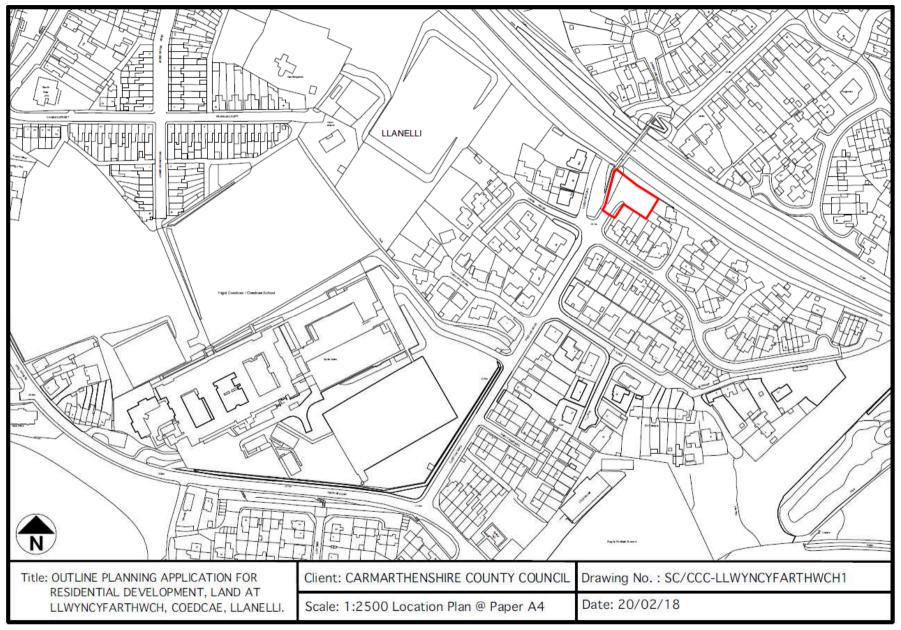


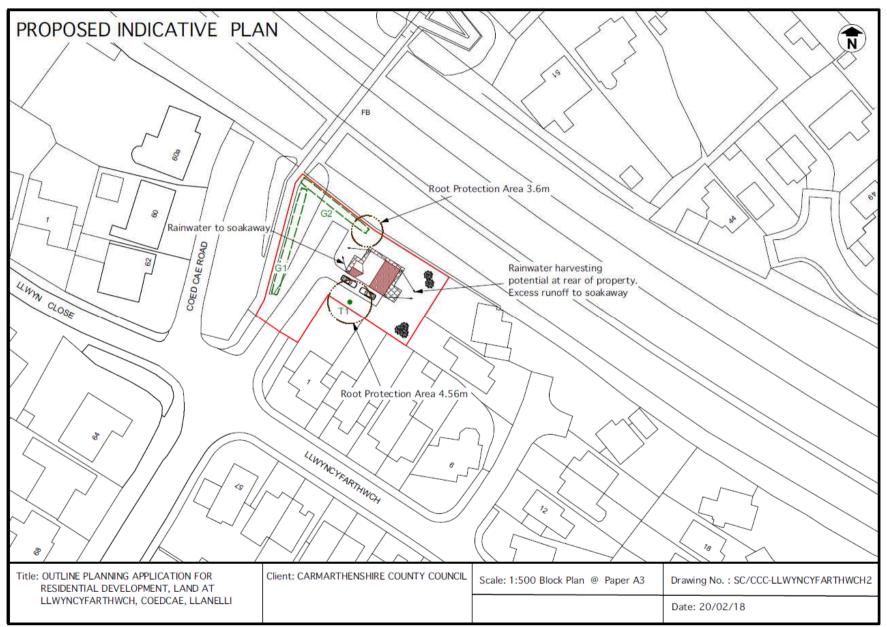








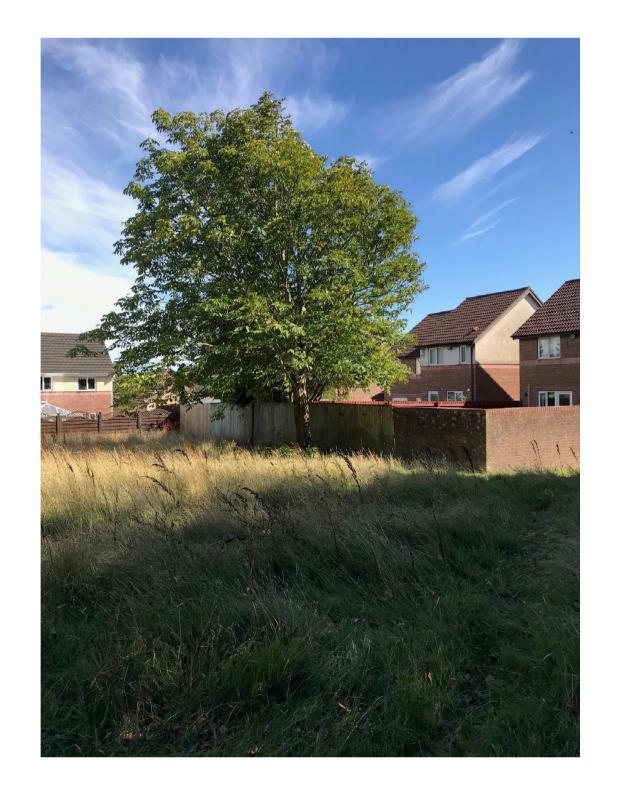





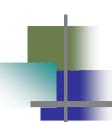





A Better Place...Environment








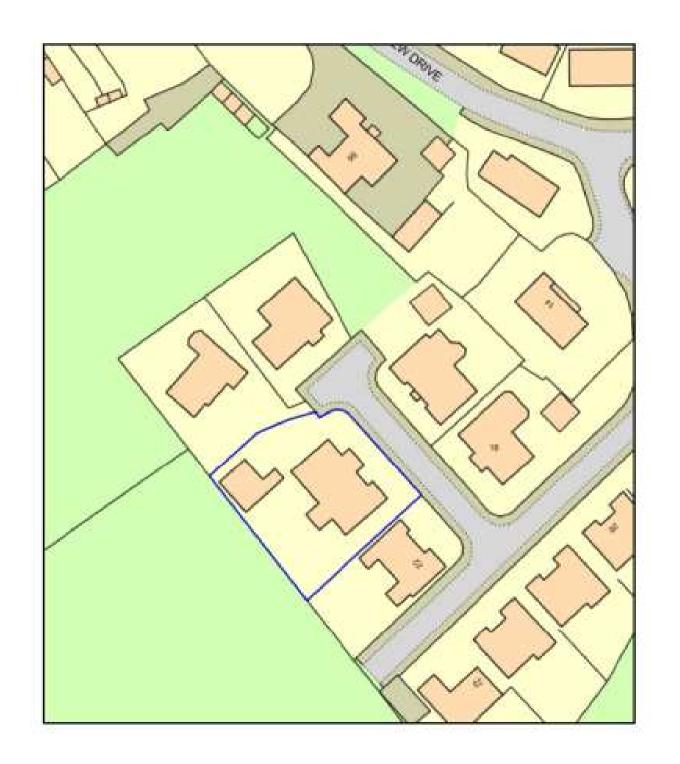

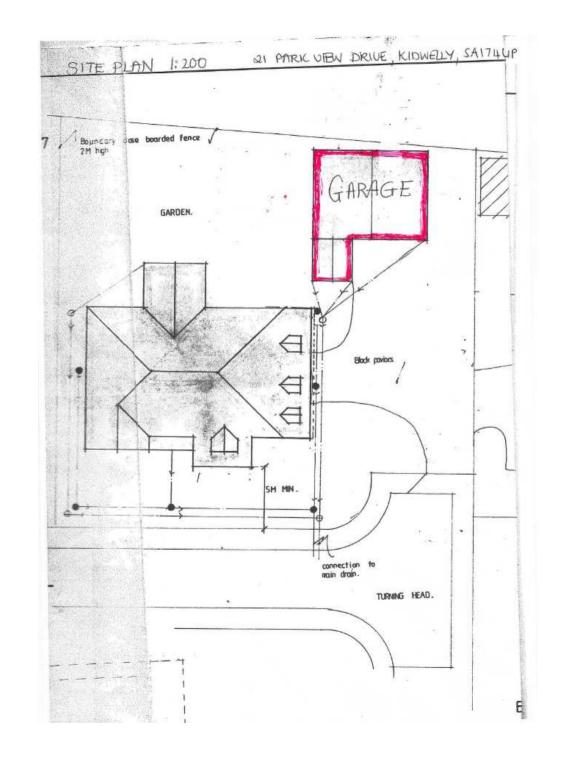

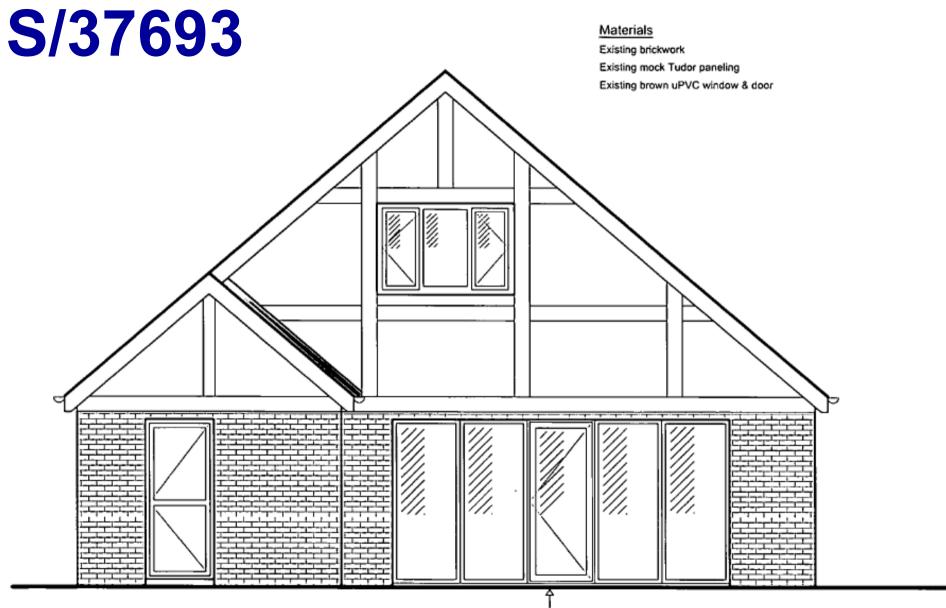

Proposed brown uPVC glazed windows


& door to replace garage door


PROPOSED ELEVATION

MR DAVID KINGDON 21 PARK VIEW DRIVE, KIDWELLY SA17 4UP


SCALE 1:50 @ A4


PLANNING

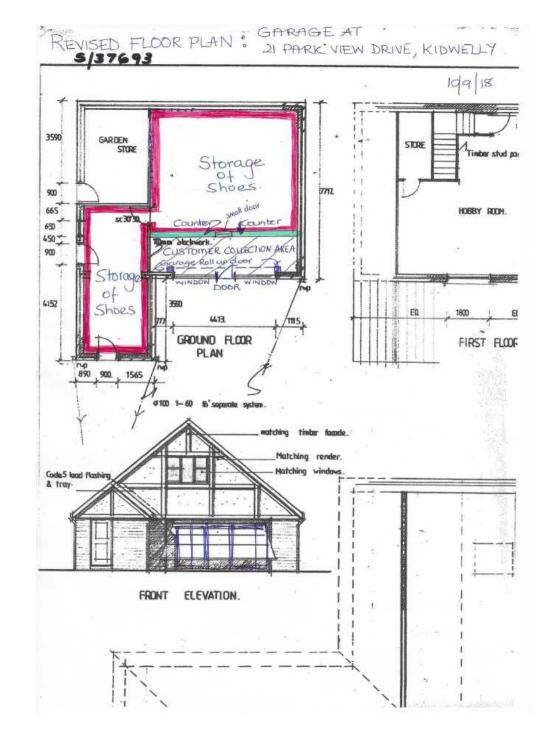

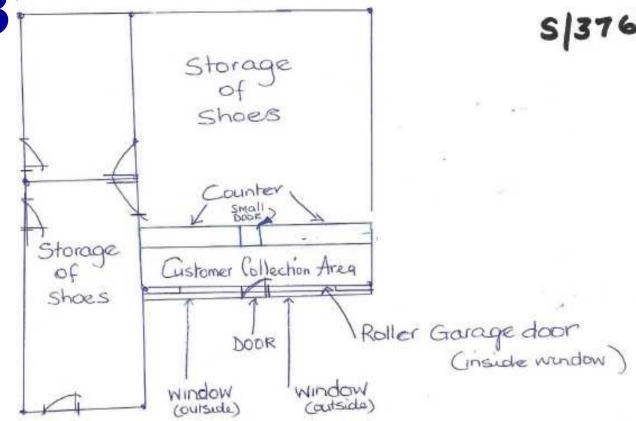


REVISED FLOOR PLAN FOR GARAGE AT 21 PARK VIEW DRIVE, KIDWELLY. 10 9 18

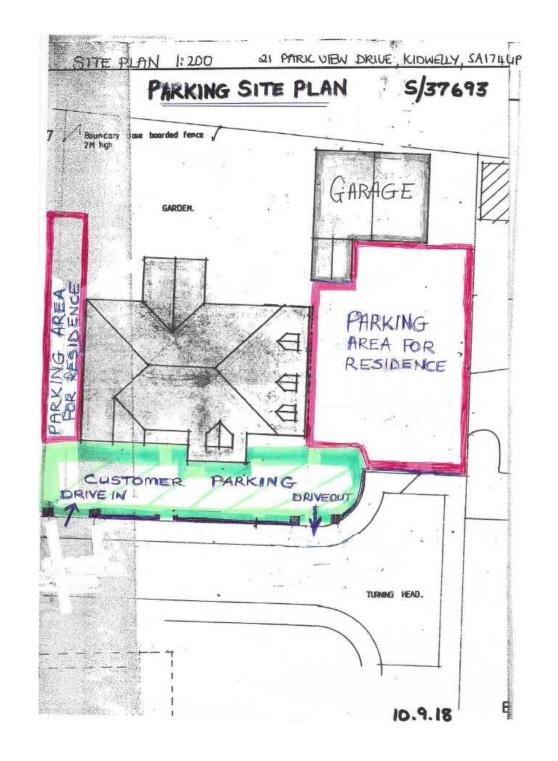

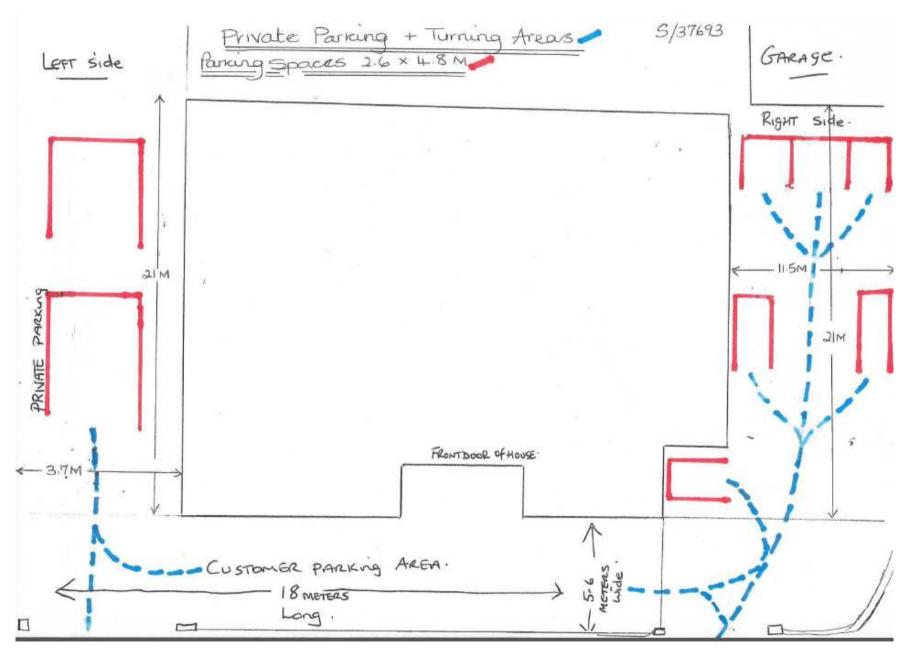





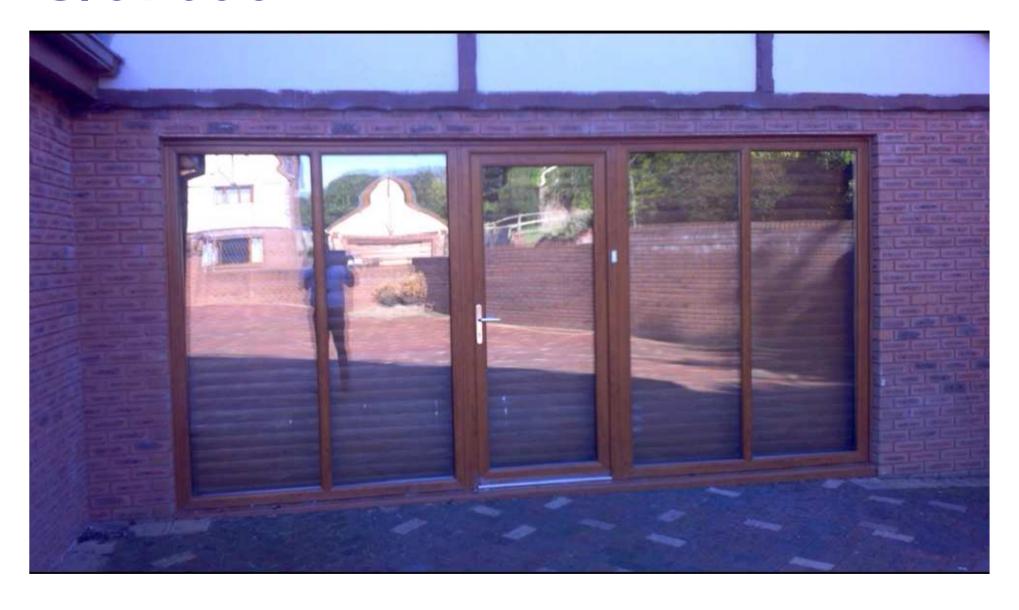






















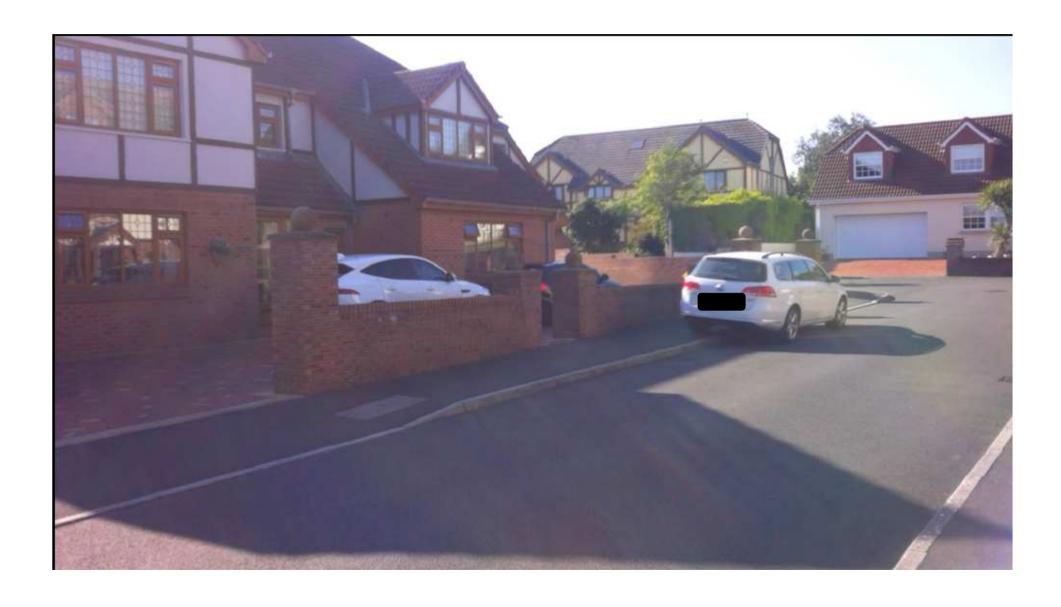







A Better Place...Environment

